






**Project Location Map**  
Not to Scale

**LEGEND**


- Boundary Line/ROW
- Edge of Road (surface labeled)
- Edge of Drive (surface labeled)
- 90 1 Foot Ground Surface Contour
- 90 Finish Grade
- Interpolated Ground Contour
- Gravity Sewer
- UE UE 1-Inch Diameter PVC Electrical Conduit
- 1-Inch Diameter Polyethylene Plastic Water Line
- Well Isolation
- Wastewater Isolation
- Tree Line
- Utility Pole
- △ Traverse Station
- TBM Temporary Bench Mark (type and elevation noted)
- ⊗ Test Pit (TP-01)
- ⊙ Percolation Test (PT-01)

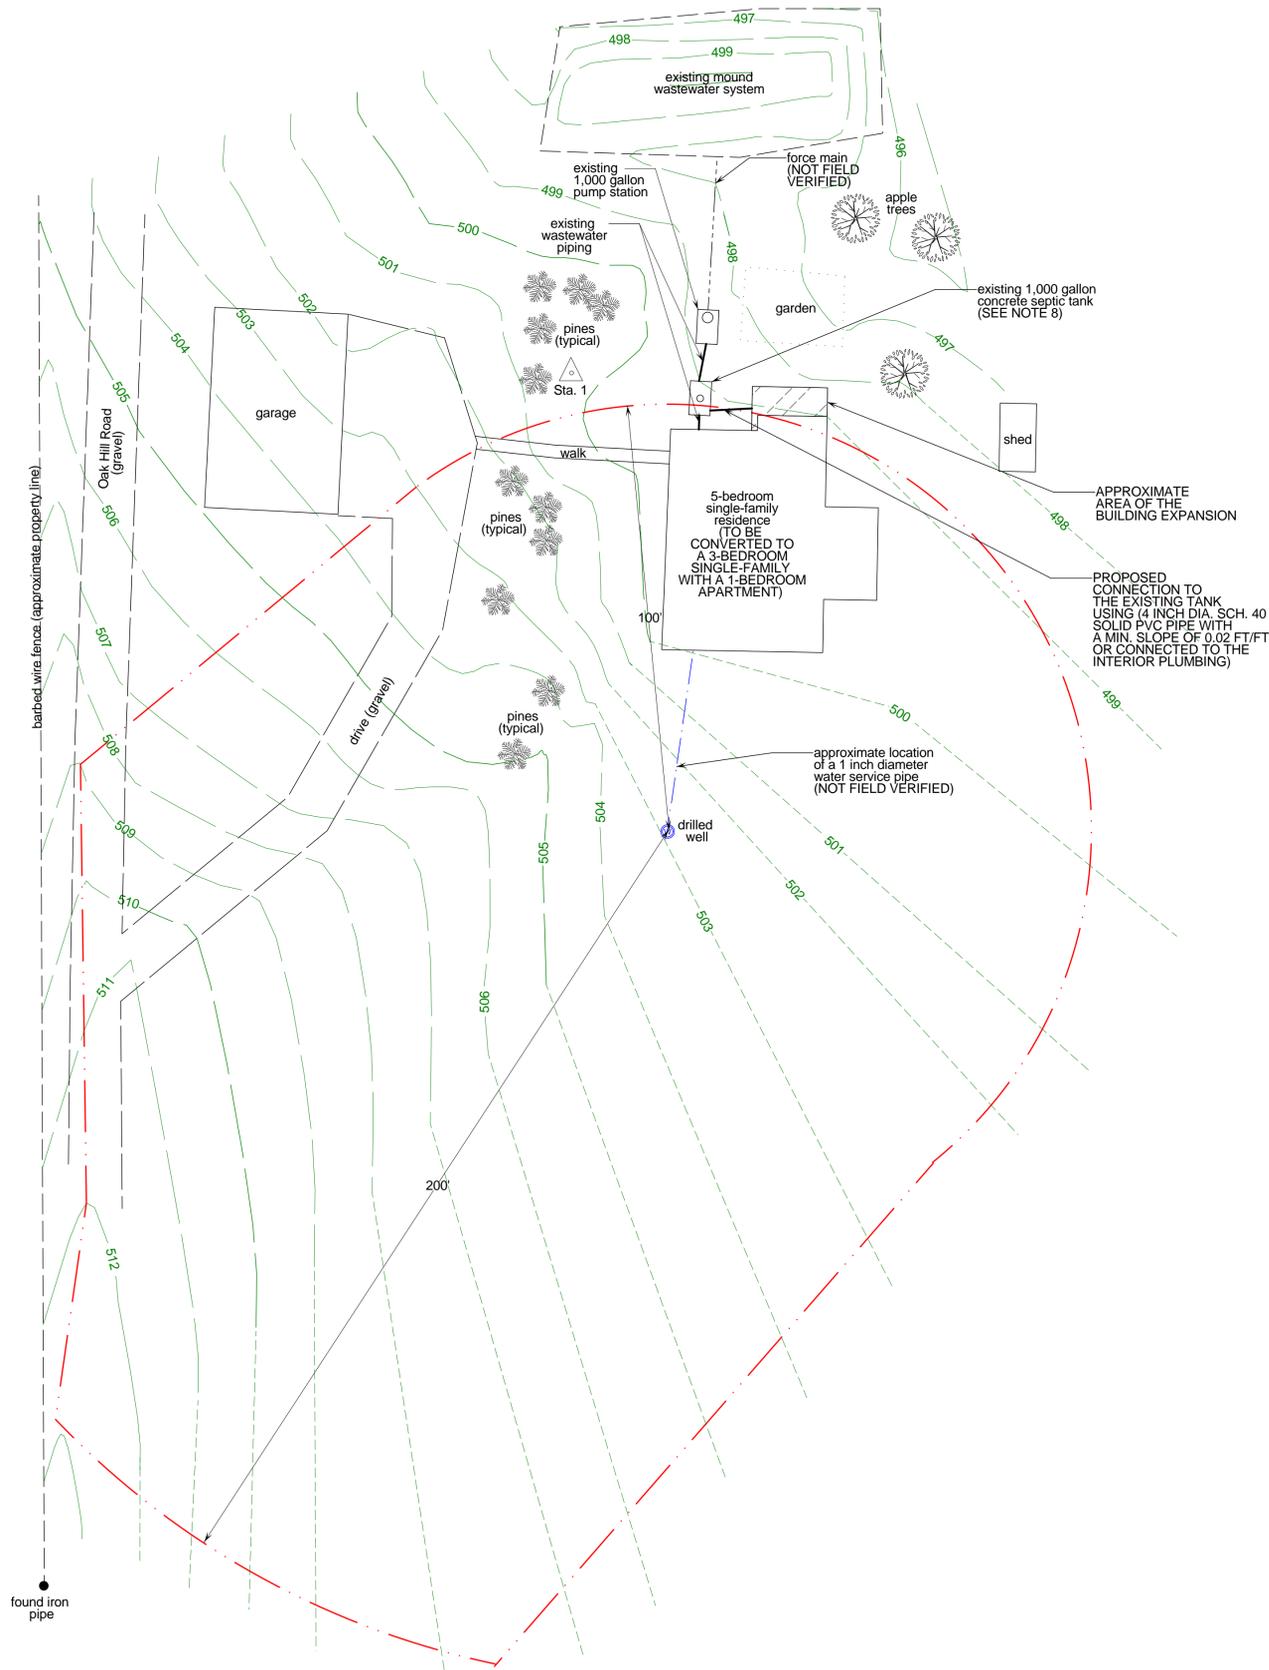

**SITE PLAN**

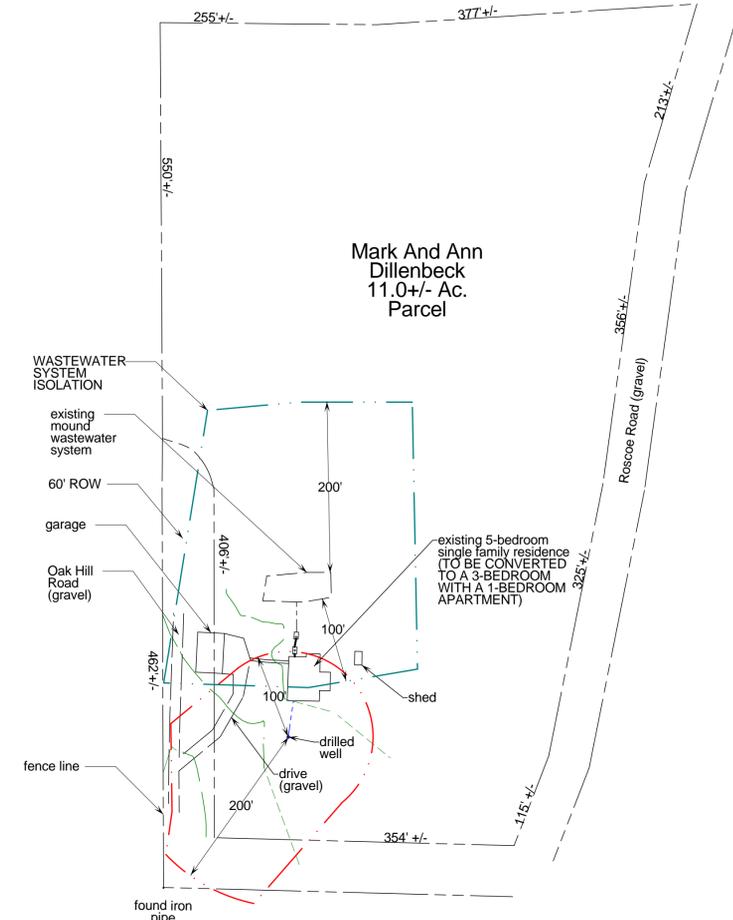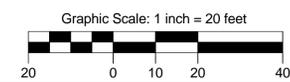

**OVERALL PROPERTY SKETCH**

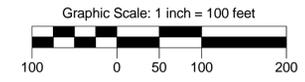

**PROJECT NOTES**

1. THESE PLANS ARE BASED ON A TOPOGRAPHIC SURVEY CONDUCTED BY JASON BARNARD CONSULTING, LLC ON MAY 27, 2010.
2. ELEVATIONS ARE BASED ON AN ASSUMED ELEVATION OF 500.00' AT STATION NO. 1.
3. PROPERTY LINES ARE BASED ON A COLBURN OUSTINOFF CORP. SURVEY PLAT DATED JULY 5, 1971 INFORMATION PROVIDED BY THE PROPERTY OWNER AND PHYSICAL EVIDENCE FOUND DURING THE MAY 27, 2010 TOPOGRAPHIC SURVEY. NO WARRANTY IS MADE TO THE ACCURACY OF THE BOUNDARY LINES SHOWN HEREON. THIS IS NOT A BOUNDARY SURVEY.
4. FOR CLARITY, TEXT IDENTIFYING EXISTING ITEMS ARE LOWER CASE, AND TEXT IDENTIFYING PROPOSED ITEMS ARE UPPER CASE.
5. BASED ON INFORMATION PROVIDED BY THE LANDOWNER AND DISCUSSIONS WITH THE TOWN OF CHARLOTTE ZONING ADMINISTRATOR, THE EXISTING MOUND SYSTEM IS PERMITTED FOR A 5-BEDROOM SINGLE-FAMILY RESIDENCE.
6. THE 11.0+/- ACRE PARCEL WAS CREATED AND DEVELOPED WITH A 5-BEDROOM SINGLE-FAMILY RESIDENCE PRIOR TO JANUARY 1, 2007.
7. THE LOCATION OF THE EXISTING MOUND WASTEWATER SYSTEM IS SHOWN BASED ON EXISTING TOPOGRAPHY AND WAS NOT FIELD VERIFIED.
8. THE EXISTING SEPTIC TANK SHALL BE RETROFITTED WITH A POLYLOK PL-122 EFFLUENT FILTER OR EQUAL. THE FILTER ACCESS SHALL BE COMPLETED FLUSH WITH EXISTING GRADE.
9. THE EXISTING MOUND SYSTEM WAS DESIGNED AND INSTALLED BY OTHERS AND THEREFORE JASON BARNARD CONSULTING, LLC ASSUMES NO FUTURE LIABILITY WITH REGARDS TO THE EXISTING MOUND SYSTEM. THE PERIMETER OF THE EXISTING MOUND SYSTEM WAS REVIEWED ON MAY 27, 2010 AND NO SIGNS OF SURFACING EFFLUENT WAS NOTED IN THE VICINITY OF THE SYSTEM.
10. THE EXISTING WATER SYSTEM WAS EVALUATED ON MAY 27, 2010 AND THE COLLECTED DATA SHOWS THE EXISTING WATER SUPPLY IS CAPABLE OF MEETING THE PROJECT AVERAGE DAILY DEMAND (ADD), MAXIMUM DAILY DEMAND (MDD) AND INSTANTANEOUS PEAK DEMAND (IPD).

<p><b>PERMITTING</b></p> <p>TITLE:</p> <p style="text-align: center;"><b>SITE PLAN AND OVERALL PROPERTY SKETCH</b></p> <p>SIGNATURE:</p> <p>JASON S. BARNARD LICENSED DESIGNER #430-B</p>	<p style="text-align: right;">4400 VT Route 17 Starksboro, VT 05487 Telephone: (802) 453-2597 Fax number: (802) 453-8497 E-mail: jbsitotech@hotmail.com</p> <p style="text-align: center;"><b>Jason Barnard Consulting, LLC</b></p> <p style="text-align: center;"><b>MARK AND ANN DILLENBECK 3-BEDROOM RESIDENCE AND 1-BEDROOM APARTMENT 104 OAK HILL ROAD CHARLOTTE, VERMONT</b></p>		
<p>DATE:</p> <p>JUNE 6, 2010</p> <p>SCALE: 1" = 20'</p> <p>DRAWN BY: MJ</p> <p>CHECKED BY: JB</p>	<p>REVISIONS:</p> <table border="1" style="width: 100%; height: 40px;"> <tr> <td style="width: 50%;"></td> <td style="width: 50%;"></td> </tr> </table> <p>DRAWING NO.</p> <p style="text-align: center; font-size: 2em;"><b>1</b></p> <p style="text-align: right;">SHEET 1 OF 1</p>		